

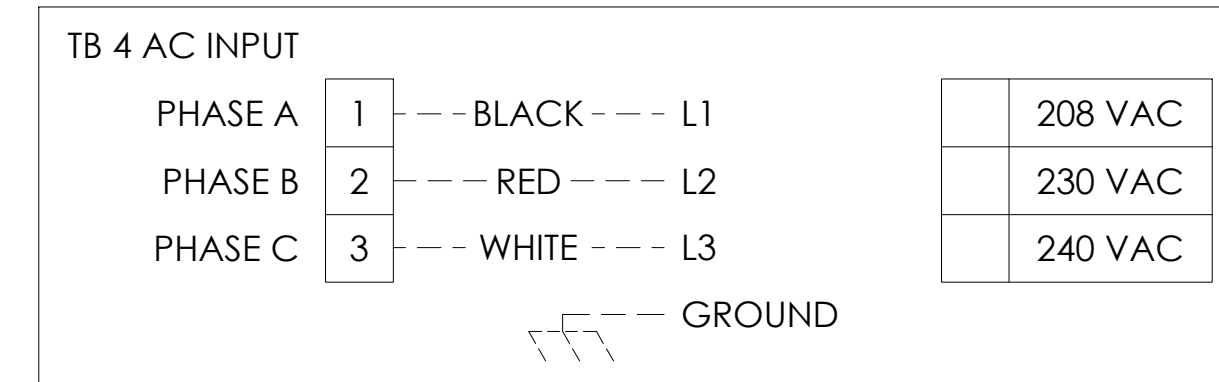


AC POWER INPUT: 208 - 240 VAC FOR 1 HP & LESS
(5 AMPS FUSED ISOLATOR)

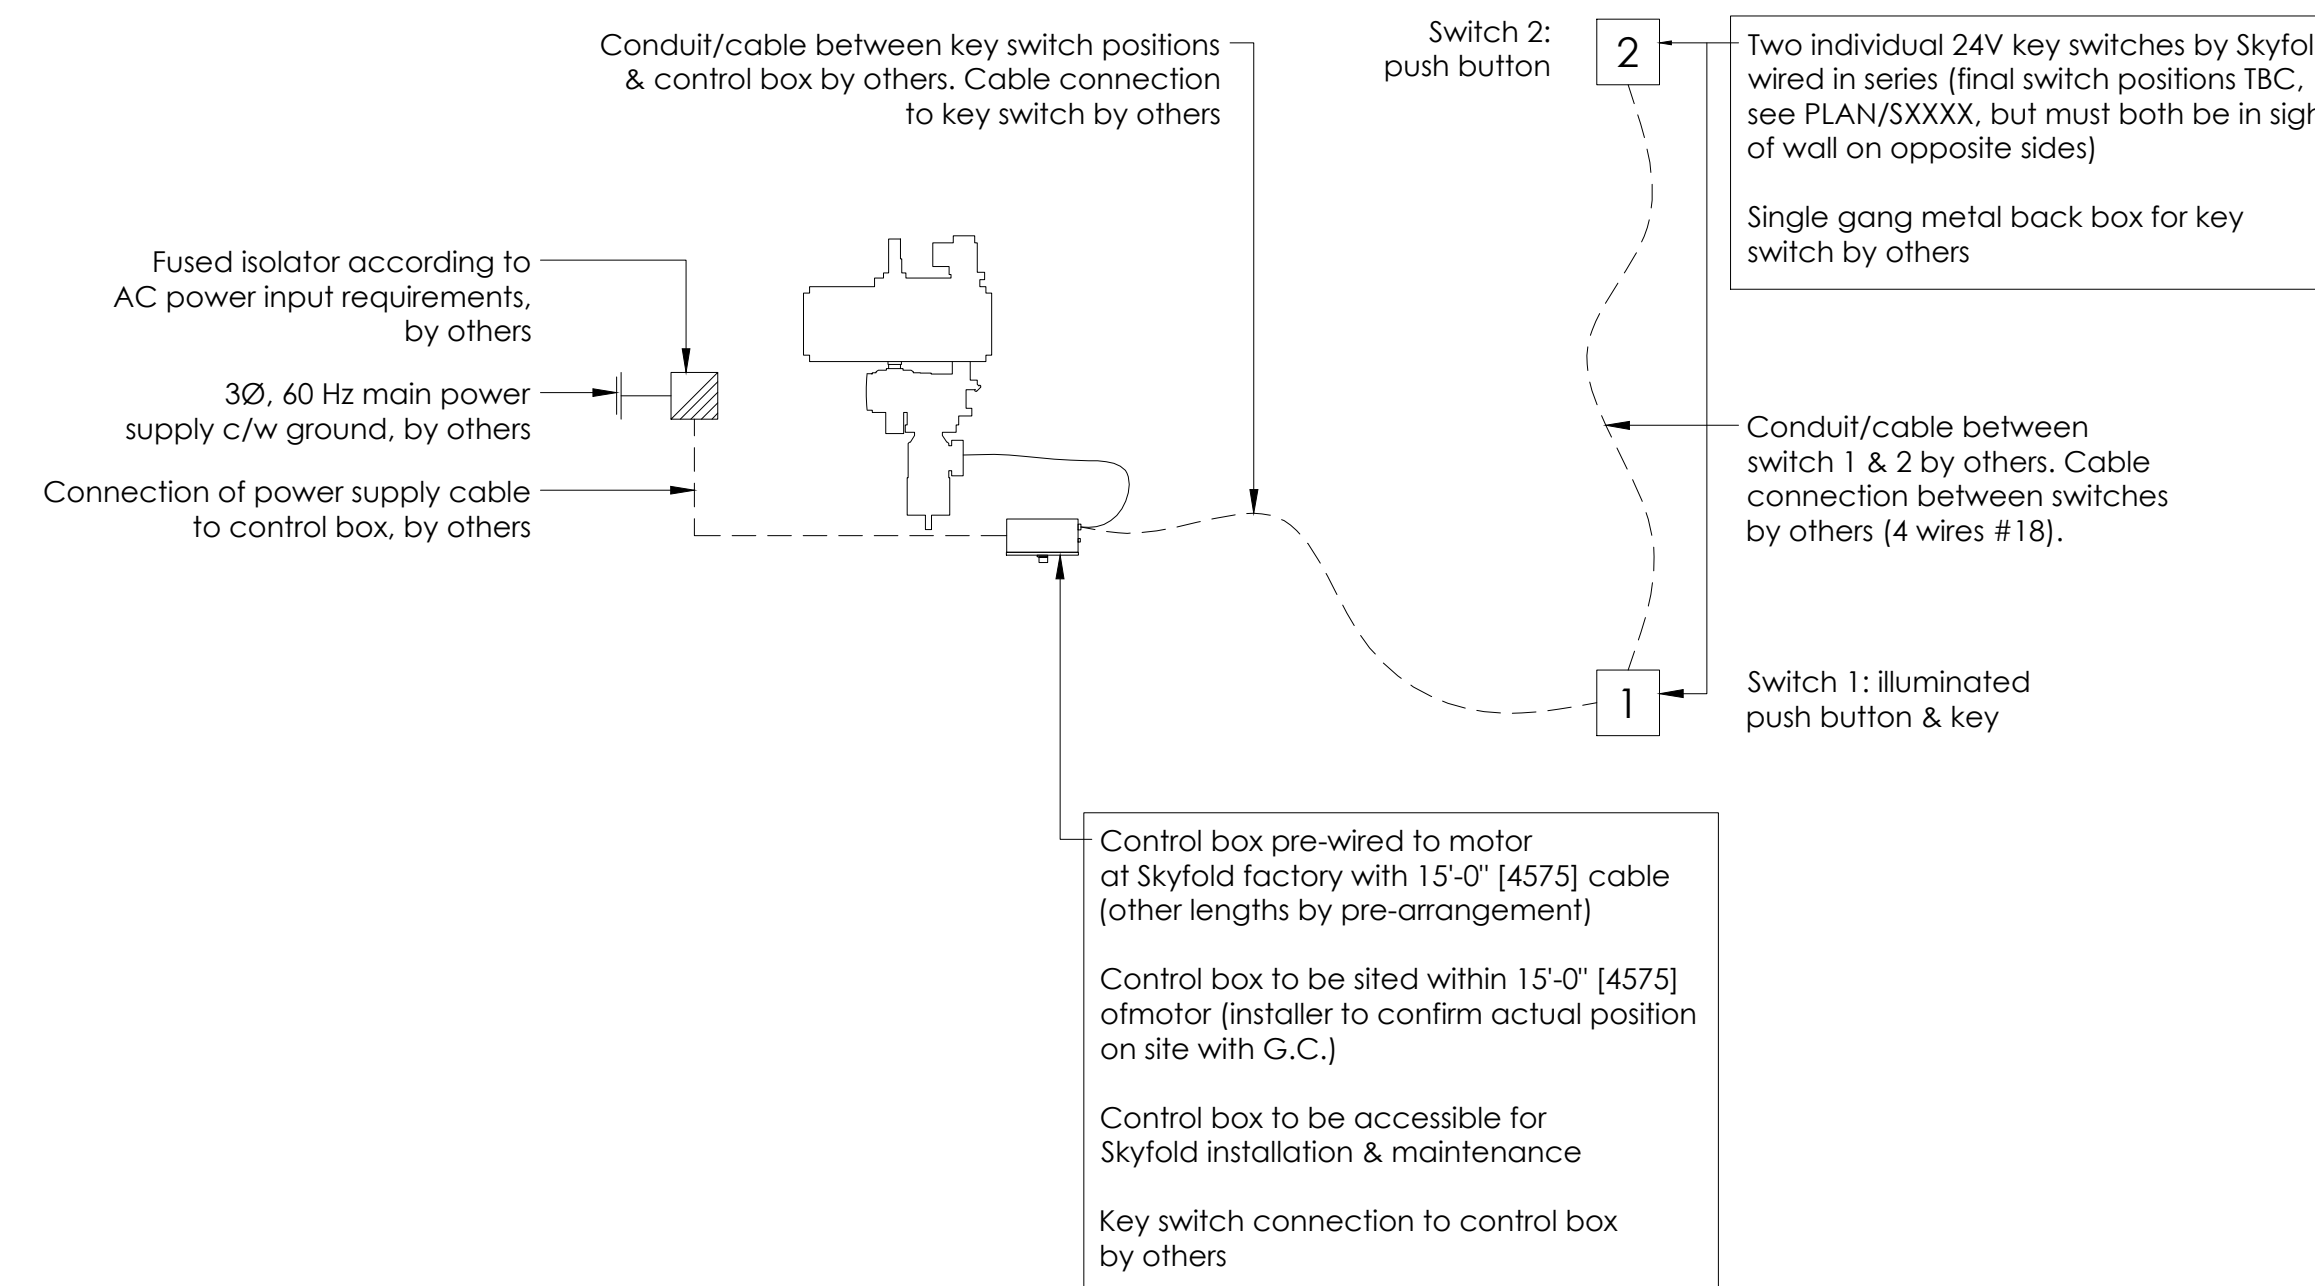


AC POWER INPUT: 208 - 240 VAC FOR 1.5 HP & GREATER AND
380 VAC & GREATER FOR ALL HP (15 AMPS FUSED ISOLATOR)

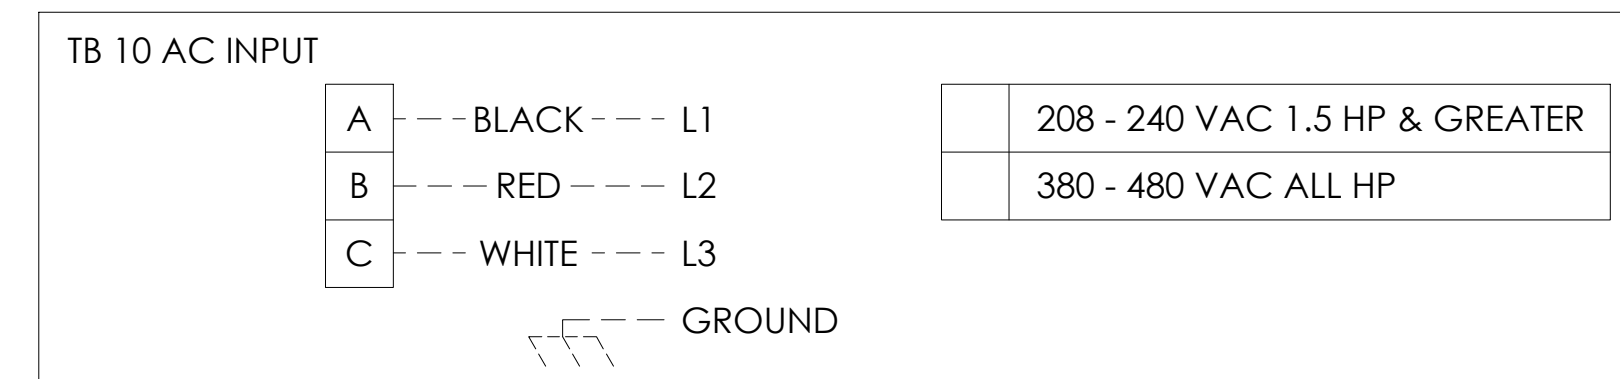


NOTES TO G.C.

- Specified electrical: 208 VAC, 3Ø, 60 Hz.
* POWER MUST BE AVAILABLE AT TIME OF INSTALLATION.
THE ELECTRICAL CONTROL BOX IS TO BE MOUNTED BY THE ELECTRICAL CONTRACTOR.
- 24 volt key switch controls & boxes to be installed by electrical contractor as per standard light switch. Boxes to be fitted at desired key switch location with suitable cable run back through ceiling void to control box position, including sufficient spare to allow connection. Key switches are supplied by Skyfold & are required on each side of the wall.
See PLAN/SXXX for key switch positions.
- Motor size: Varies - project-specific
Full load amp: XXXX A
- Do not scale from this drawing. All dimensions must be verified on site.
- Dimensions in [] are in millimeters (mm) unless noted otherwise.


WIRING DIAGRAM FOR ILLUMINATED PUSH BUTTON & KEY SWITCHES IN SERIES (SKYFOLD SWITCHES ONLY)

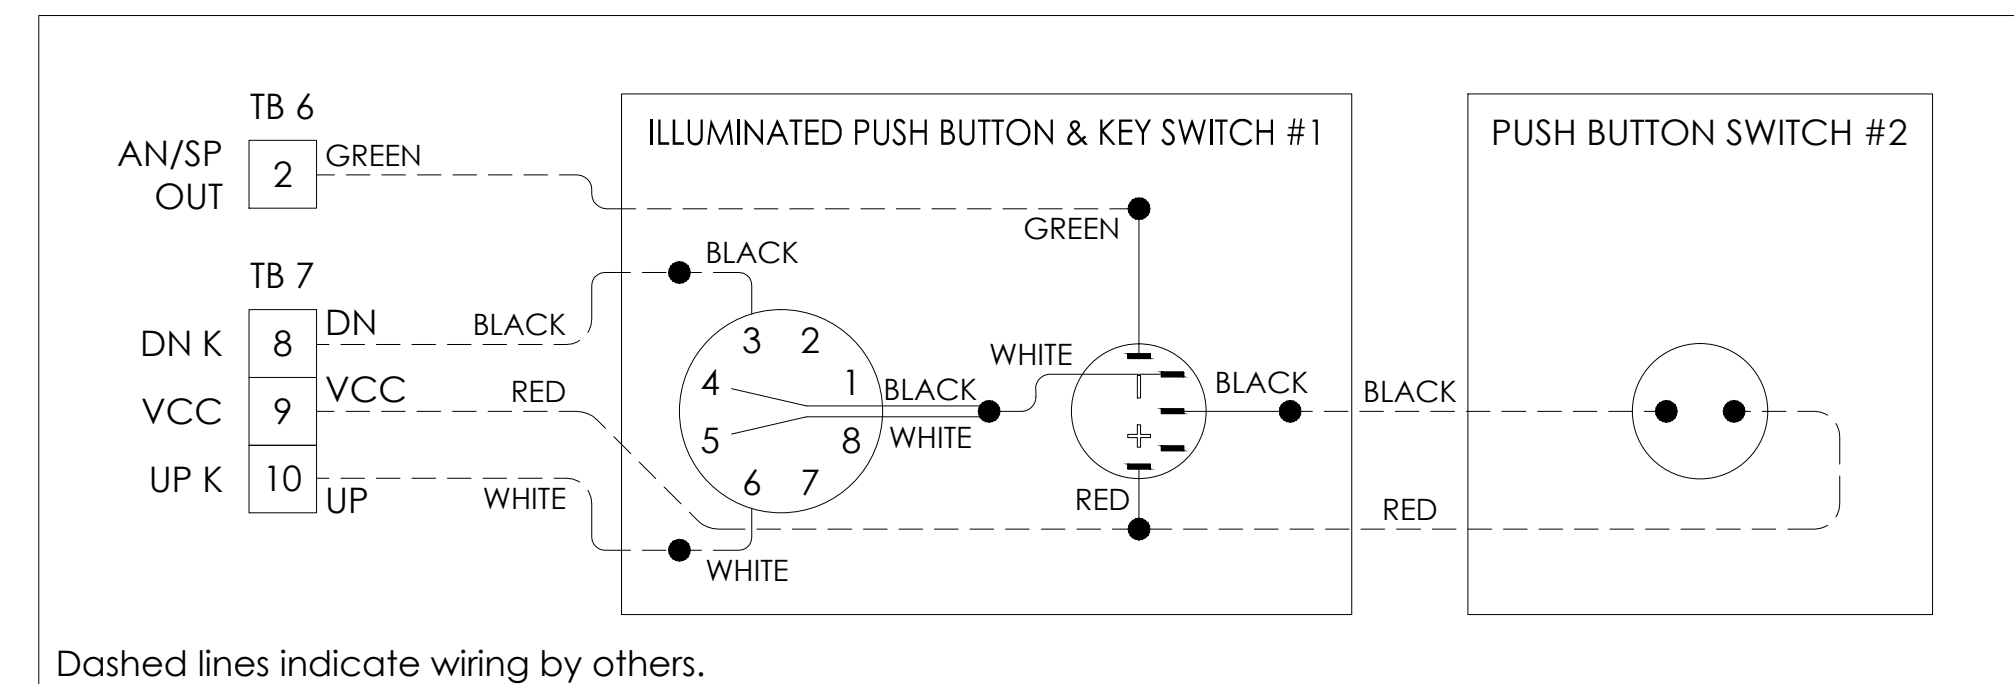

ELECTRICAL PLAN
SCALE: NONE

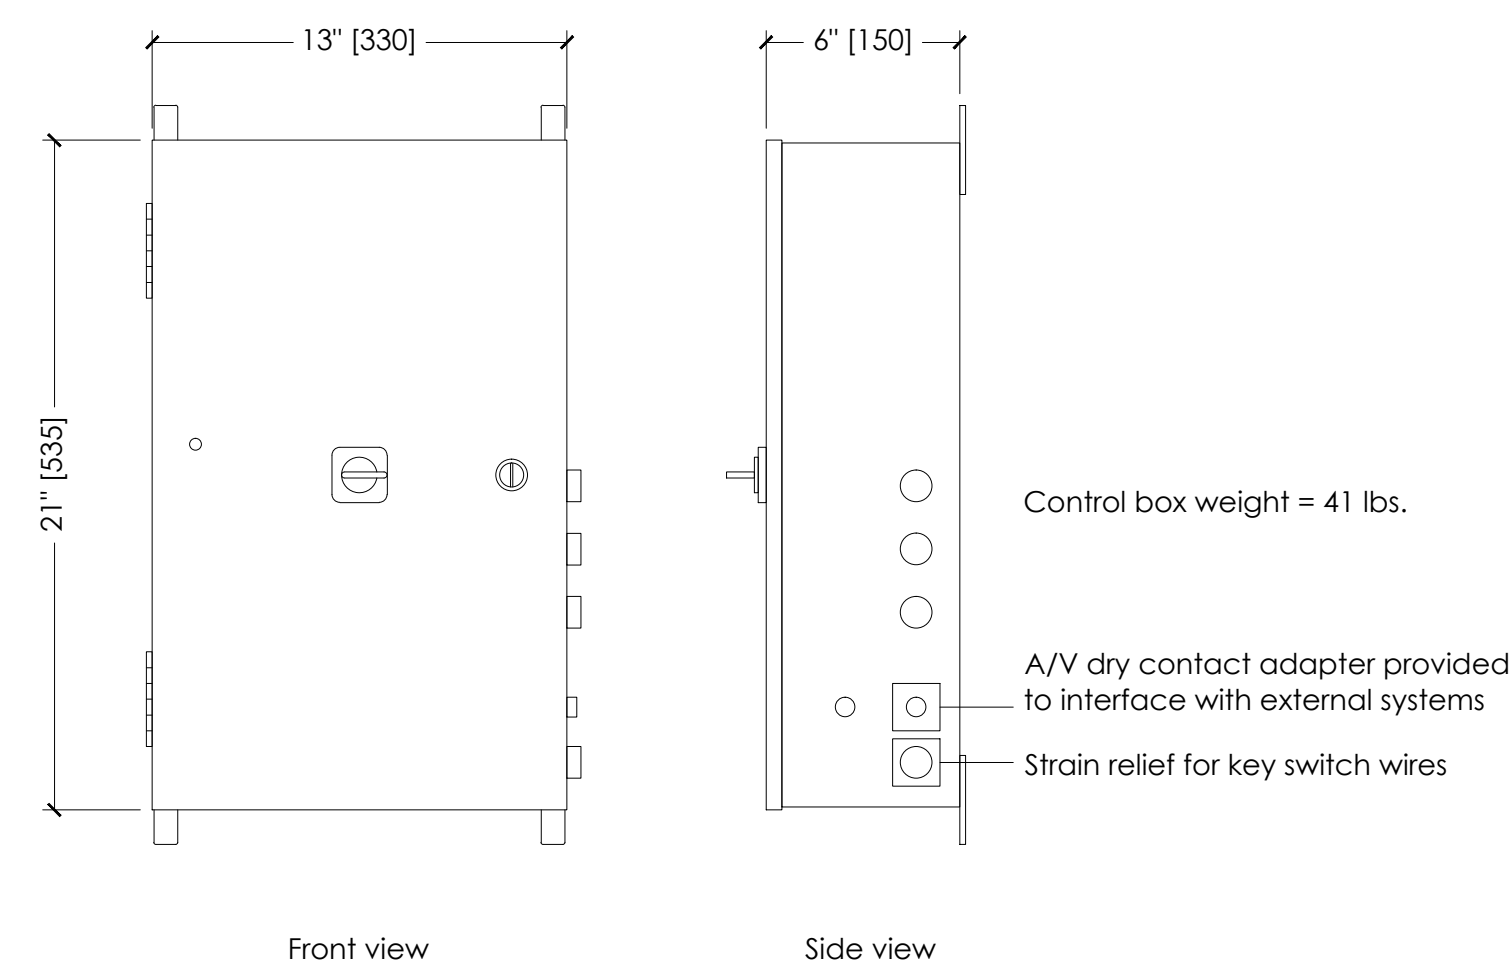


CONTROL BOX
SCALE: NONE

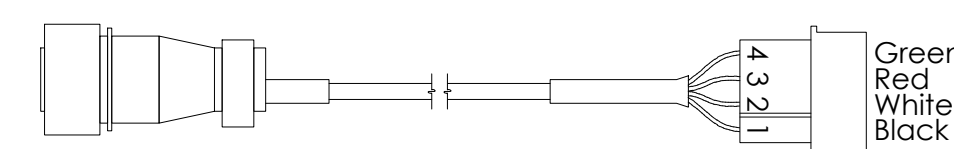

Wall at lower limit, pins 1+2 close
Wall at upper limit, pins 3+4 close
Contact maximum ratings
250mA @ 24VAC/DC max

A/V ADAPTER PLUG ASSEMBLY
(SOCKET CONNECTOR INCLUDED)
SCALE: NONE

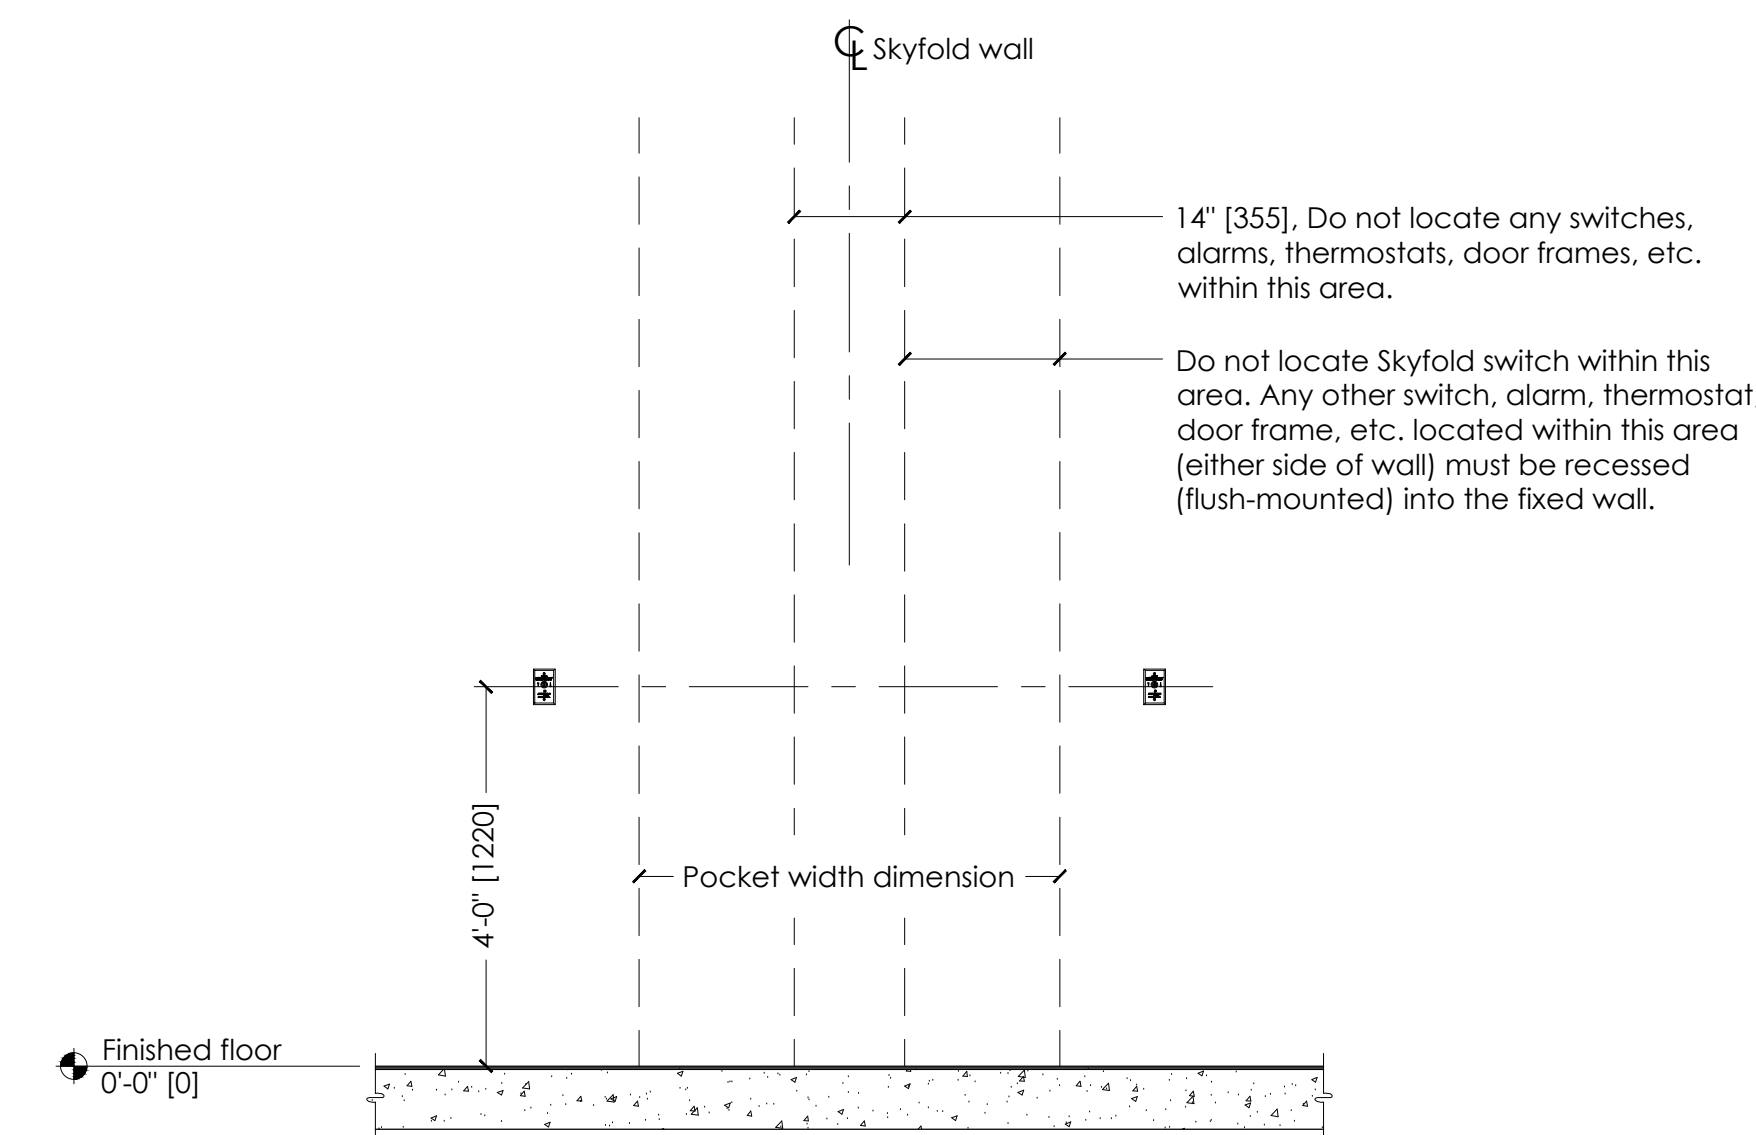

ELEVATION SHOWING KEY SWITCHES
SCALE: 1/2" = 1'-0"

THIS DRAWING IS INTENDED AS A GUIDE. IN ALL CASES SKYFOLD SHOP DRAWINGS SPECIFIC TO EACH PROJECT ARE REQUIRED FOR FINAL BUILD-TO DIMENSIONS.

Authorized Skyfold distributor

Project

TYPICAL SKYFOLD WALL

Drawing title

X @ X'-X" [XXXX] x X'-X" [XXXX] B.O. Pocket Standard drive unit

ELECTRICAL DETAILS

Architect

Contractor

Drawn by

Date

Approved by

Date

Skyfold project No.

Scale

Sheet No.

Drawing No.

As noted

3 of 3

SXXXZ

Revision

5